


# **KINGSTON 4 NH**

# **OFF HUNT ROAD** KINGSTON, NH 03848

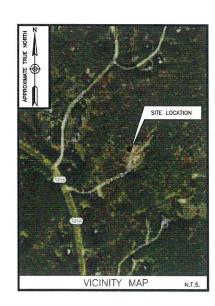

DEWBERRY ENGINEERS INC. 99 SUMMER ST. SUITE 700 BOSTON, MA 02110

CONTACT: BENJAMIN B. REVETTE

CONSTRUCTION VERIZON WIRELESS 900 CHELMSFORD STREET TOWER 2 FLOOR 5 LOWELL, MA 01581

PHONE # (603) 505-0700 CONTACT: TODD WHITE

PROJECT TEAM

SITE NAME: KINGSTON 4 NH

PROPERTY OWNER:

ELECTRIC UTILITY: UNITIL (888) 301-7700

TELEPHONE UTILITY; CONSOLIDATED COMMUNICATIONS (844) 968-7224

COORDINATES\*:
LATITUDE: 42' 52' 44.58" N (NAD83)
LONGITUDE: 71' 07' 22.73" W (NAD83)
\*PER FAA-2C

PROJECT SUMMARY

SITE ADDRESS:

ZONING DISTRICTS:
TOWN OF KINGSTON, NH: RURAL-RESIDENTIAL (RR)
TOWN OF PLAISTOW, NH: RESIDENTIAL CONSERVATION 2 (RC

PROJECT DIRECTORY

PROJECT DESCRIPTION

THIS DOCUMENT WAS DEVELOPED TO REFLECT A SPECIFIC SITE AND ITS SITE CONDITIONS AND IS NOT TO BE USED FOR ANOTHER SITE OR WHEN OTHER CONDITIONS PETITIAN. REUSE OF THIS DOCUMENT IS AT THE SOLE RISK OF THE USER. A.D.A. COMPLIANCE: FACILITY IS UNMANNED AND NOT FOR HUMAN HABITATION.

CONSTRUCTION **DRAWINGS** ZONING FOR NOT

DESCRIPTION

ABUTTERS PLAN

Z-3 EXISTING CONDITIONS PLAN PROPOSED CONDITIONS PLAN COMPOUND PLAN & ELEVATION

Z-6 TYPICAL DETAILS-I
Z-7 TYPICAL DETAILS-II

SITE PLAN/AERIAL OVERLAY

SHEET INDEX



KINGSTON 4 NH

	ZONING	DRAWINGS
	/ /	505 6USUUTTU
1	10/20/23	FOR SUBMITTAL
0	03/14/23	FOR SUBMITTAL FOR COMMENT



Dewberry Engineers Inc.
98 SUMMER STREET
SUITE 709
BOSTON, MA 02110
PHONE 617.695.3400
FAX: 617.695.3310



DRAWN BY:	JG
REVIEWED BY:	OAS
CHECKED BY:	BBR
PROJECT NUMBER:	50121487
JOB NUMBER:	50150912
SITE LOCATION CODE	(PSLC):

SITE ADDRESS


OFF HUNT ROAD KINGSTON, NH 03848

SHEET TITLE

SHEET NUMBER

TITLE SHEET


T-1

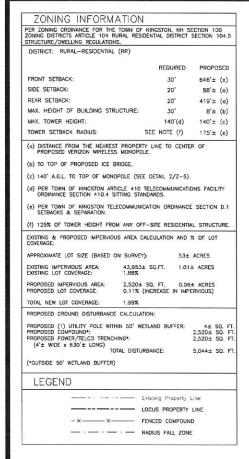

## NOTES:

OWNER OF RECORD; DAVID KIMBALL
 43 BACK ROAD
 DANVILLE NH 03819

- 2. SOURCE OF TITLE; BOOK 3503 PAGE 2779
- 3. APPROXIMATE AREA: 53 ACRES.
- BEARING SYSTEM IS BASED UPON NH STATE PLANE (NAD'83) USING U.S. SURVEY FOOT AND VERTICAL DATUM IS BASED UPON NAVD'88 (GEOID,128) USING AN OPUS SOLUTION OF STATIC GPS DATA.
- 5. AUDRA L. KLUMB, NH CERTIFIED WETLAND SCIENTIST #222 OF A&D KLUMB ENVIRONMENTAL, LLC, WEBSTER, NH, PERFORMED THE WETLAND MAPPING FOR THIS SITE ON DECEMBER 13, 2022 ACCORDING TO THE TECHNICAL CRITERIA OF THE US ARMY CORPS OF ENGINEERS DELINEATION MANUAL (TECHNICAL REPORT Y-BF-1, JANUARY 1987), THE REGIONAL SUPPLEMENT TO THE CORPS OF ENGINEERS WETLAND DELINEATION MANUAL: NORTH CENTRAL AUM NORTHEAST REGION, VERSION 2.0 (JANUARY 2012), AND NH STATUTE RSA482-A:2 X.
- BOUNDARY INFORMATION SHOWN WAS TAKEN FROM DEEDS AND PHYSICAL EVIDENCE FOUND. THIS PLAN IS NOT INTENDED TO BE A BOUNDARY SURVEY.
- NO STATUS WAS FOUND FOR THE "OLD ROAD" SHOWN ON THIS PLAN. BOTH HAMPSTEAD AND PLAISTOW SHOW THIS ROAD ON THEIR TAX MAPS. KIMBALL PROVIDES MAINTENANCE FOR THE ACCESS.
- 8. THIS SHEET IS A TAX MAP COMPILATION AND IS NOT INTENDED TO BE A BOUNDARY SURVEY, OWNERS LISTED ON PLASTOW TAX MAP 22 LOTS 22 AND 17 DO NOT APPEAR TO MARCH THE TITLE RECORD OWNERS BUT THIS PLANS LISTS ALL POTENTIAL ABUTTERS TO THE KIMBALL PROPERTY.

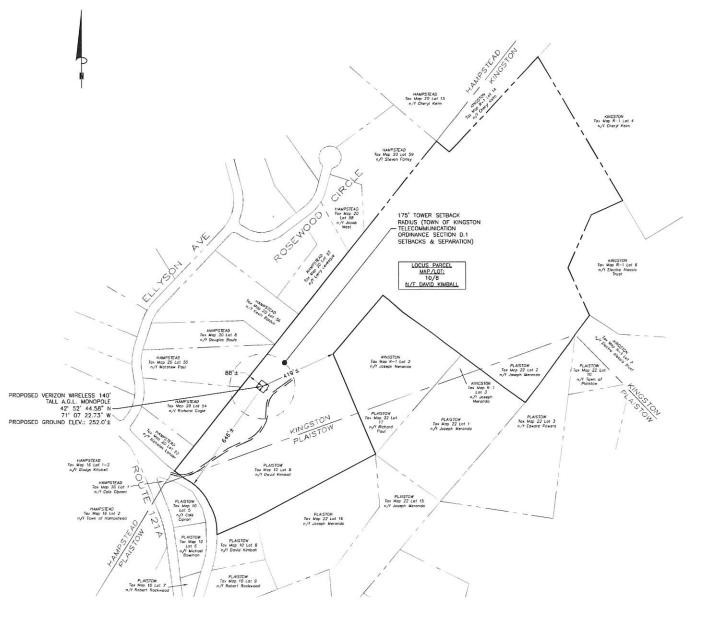

ABUTTERS PLAN

SCALE: 1"=400' FOR 11"x17" 1"=200' FOR 22"x34"



VERIZON WIRELESS 900 CHELMSFORD STREET TOWER 2 FLOOR 5 LOWELL, MA 01851

KINGSTON 4 NH

	ZONING	DRAWINGS
1	10/20/23	FOR SUBMITTAL
0	03/14/23	FOR SUBMITTAL
Α	02/13/23	FOR COMMENT



Dewberry Engineers Inc.

99 SUMMER STREET
SUITE 700
BOSTON, MA 02110
PHONE 617-695-3400
FAX: 617.695-3310



DRAWN BY:	JG
REVIEWED BY:	OAS
CHECKED BY:	BBR
PROJECT NUMBER:	50121487
JOB NUMBER:	50150912
SITE LOCATION CODE (PS	SLC):

706213

SITE ADDRESS

OFF HUNT ROAD KINGSTON, NH 03848

SHEET TITLE

ABUTTERS PLAN

SHEET NUMBER

Z - 1





## NOTES:

- OWNER OF RECORD: DAVID KIMBALL
   43 BACK ROAD
   DANVILLE, NH 03819
- 2. SOURCE OF TITLE: BOOK 3503 PAGE 2779
- 3. APPROXIMATE AREA: 53 ACRES.
- BEARING SYSTEM IS BASED UPON NH STATE PLANE (NAD'83) USING U.S. SURVEY FOOT AND VERTICAL DATUM IS BASED UPON NAVD'88 (GEOID.128) USING AN OPUS SOLUTION OF STATIC GPS DATA.
- 5. AUDRA L. KLUBB, H. CERTHER WELLAND SCENTIST #222
  OF ARD KLUBB ENVIRONMENTAL LLC, WEBSTER, W.
  PERFORMED THE WELLAND MAPPING FOR FINS STE ON
  DECKHER 19, 2022 ACCORDING TO THE TECHNICAL
  CRITERIA OF THE US ARMY CORPS OF ENKNIERS
  DELINEATION MANUAL (TECHNICA, REPORT Y-57-1, JANUARY
  1897), THE REGIONAL SUPPLIEMENT TO THE CORPS OF
  ENGINEERS WETLAND DELINEATION MANUAL: NORTH CENTRAL
  AND NORTHEAST REGION, VERSION 2.0 (JANUARY 2012), AND
  NH STATUTE RSA482-A:2 X.
- BOUNDARY INFORMATION SHOWN WAS TAKEN FROM DEEDS AND PHYSICAL EVIDENCE FOUND. THIS PLAN I NOT INTENDED TO BE A BOUNDARY SURVEY.
- NO STATUS WAS FOUND FOR THE "OLD ROAD" SHOWN ON THIS PLAN. BOTH HAMPSTEAD AND PLAISTOW SHOW THIS ROAD ON THEIR TAX MAPS. KIMBALL PROVIDES MAINTENANCE FOR THE ACCESS.

SITE PLAN/AERIAL OVERLAY
SCALE: 1"=100' FOR 11"x17"





VERIZON WIRELESS 900 CHELMSFORD STREET TOWER 2 FLOOR 5 LOWELL, MA 01851

KINGSTON 4 NH

	ZONING	DRAWINGS
1	10/20/23	FOR SUBMITTAL
0	03/14/23	FOR SUBMITTAL
Α	02/13/23	FOR COMMENT



Dewberry Engineers Inc.
98 SUMMER STREET
SUITE 700
BOSTON, MA 02:10
PHONE 67:7695.3400
FAX: 617.695.3310



DRAWN BY:	JG
REVIEWED BY:	OAS
CHECKED BY:	BBR
PROJECT NUMBER:	50121487
JOB NUMBER:	50150912
SITE LOCATION CODE (F	SLC):

706213

SITE ADDRESS


OFF HUNT ROAD KINGSTON, NH 03848


SHEET TITLE


SITE PLAN/AERIAL OVERLAY


SHEET NUMBER


Z-2

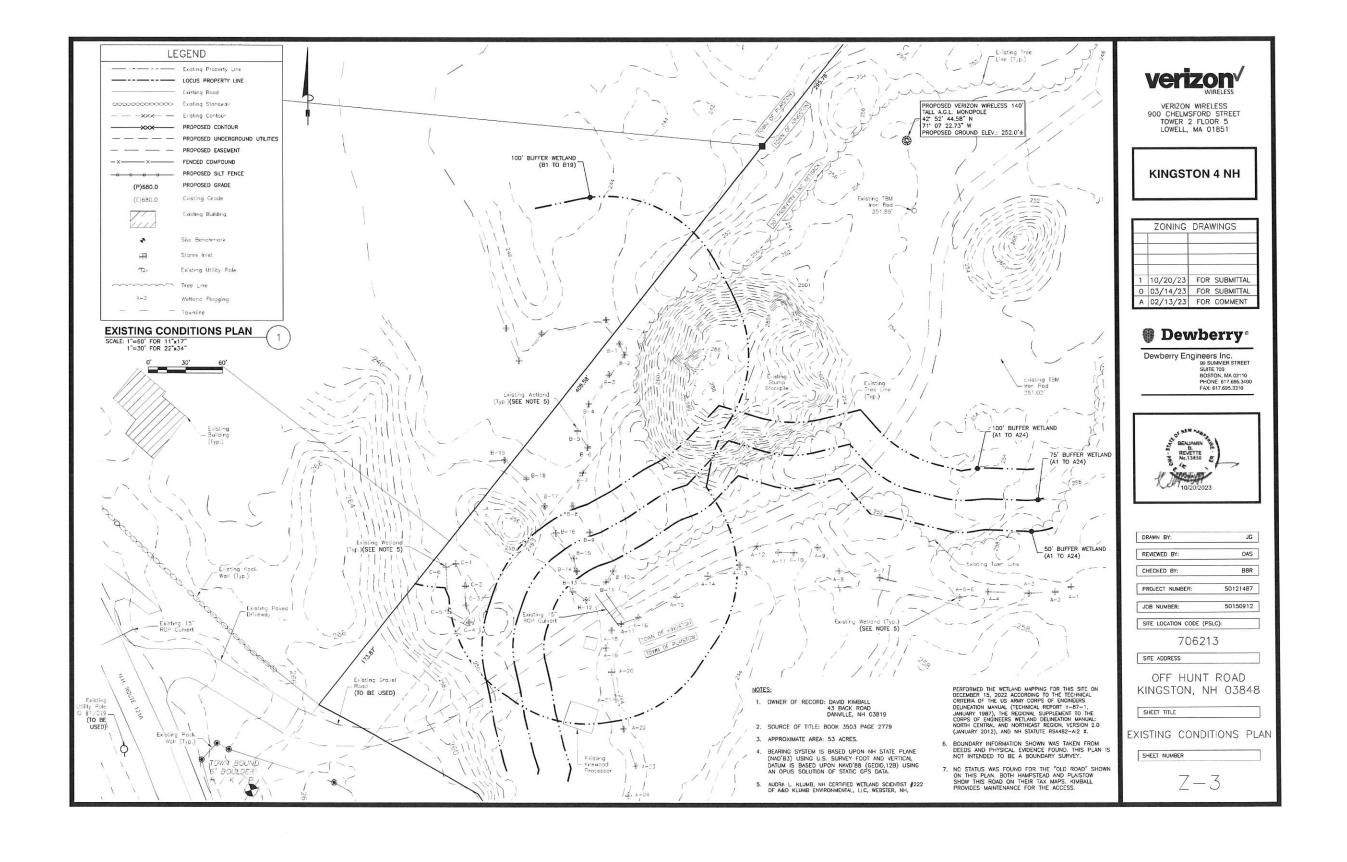

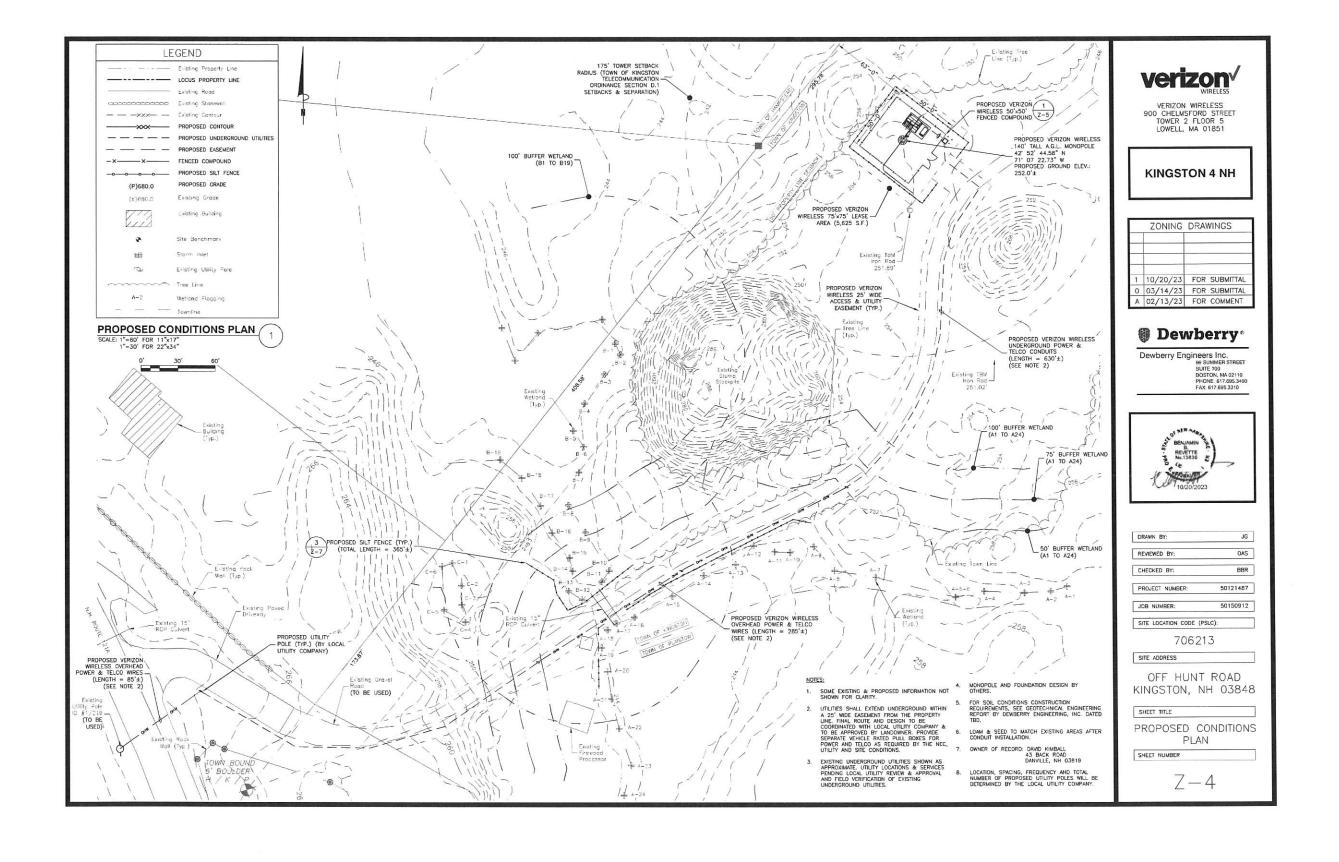

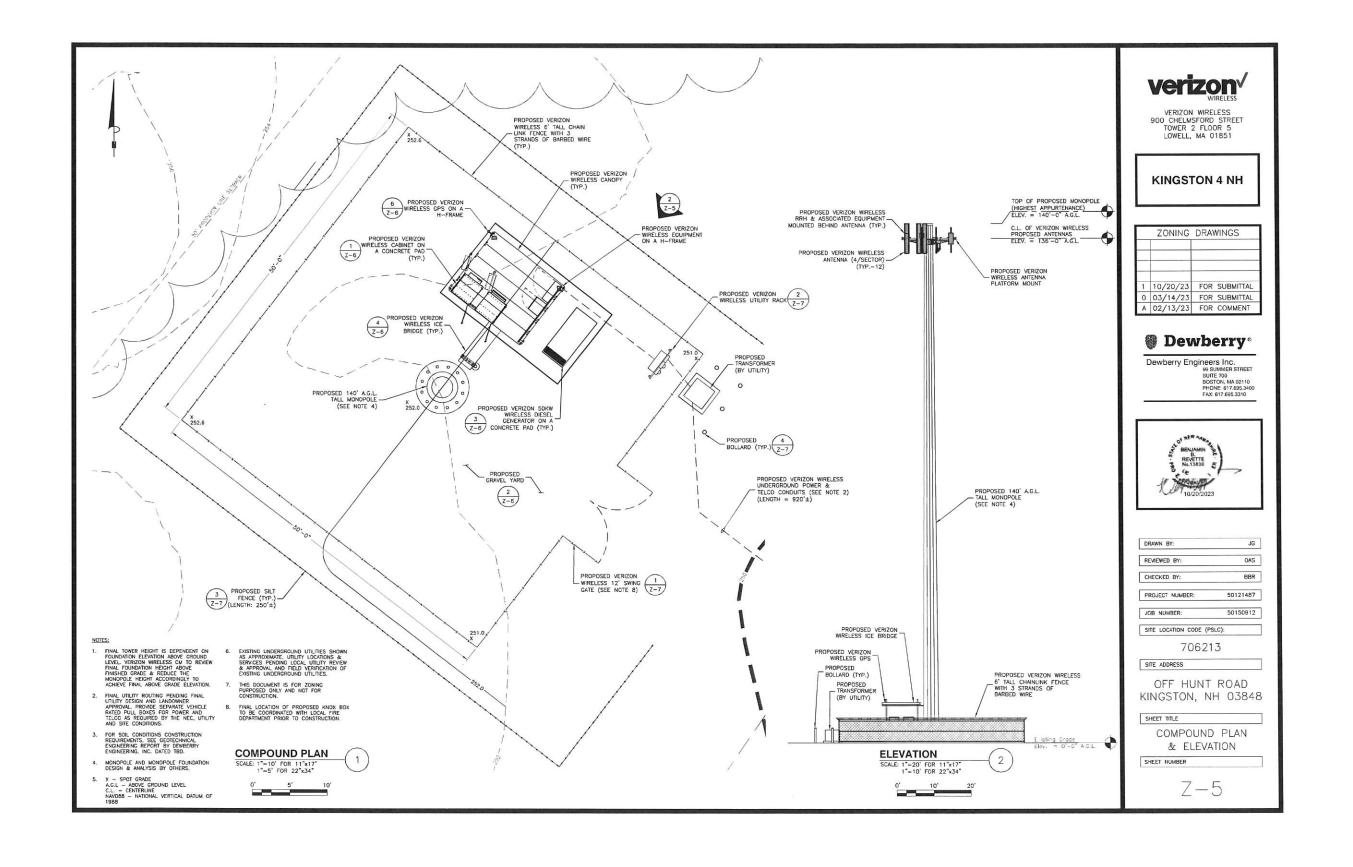

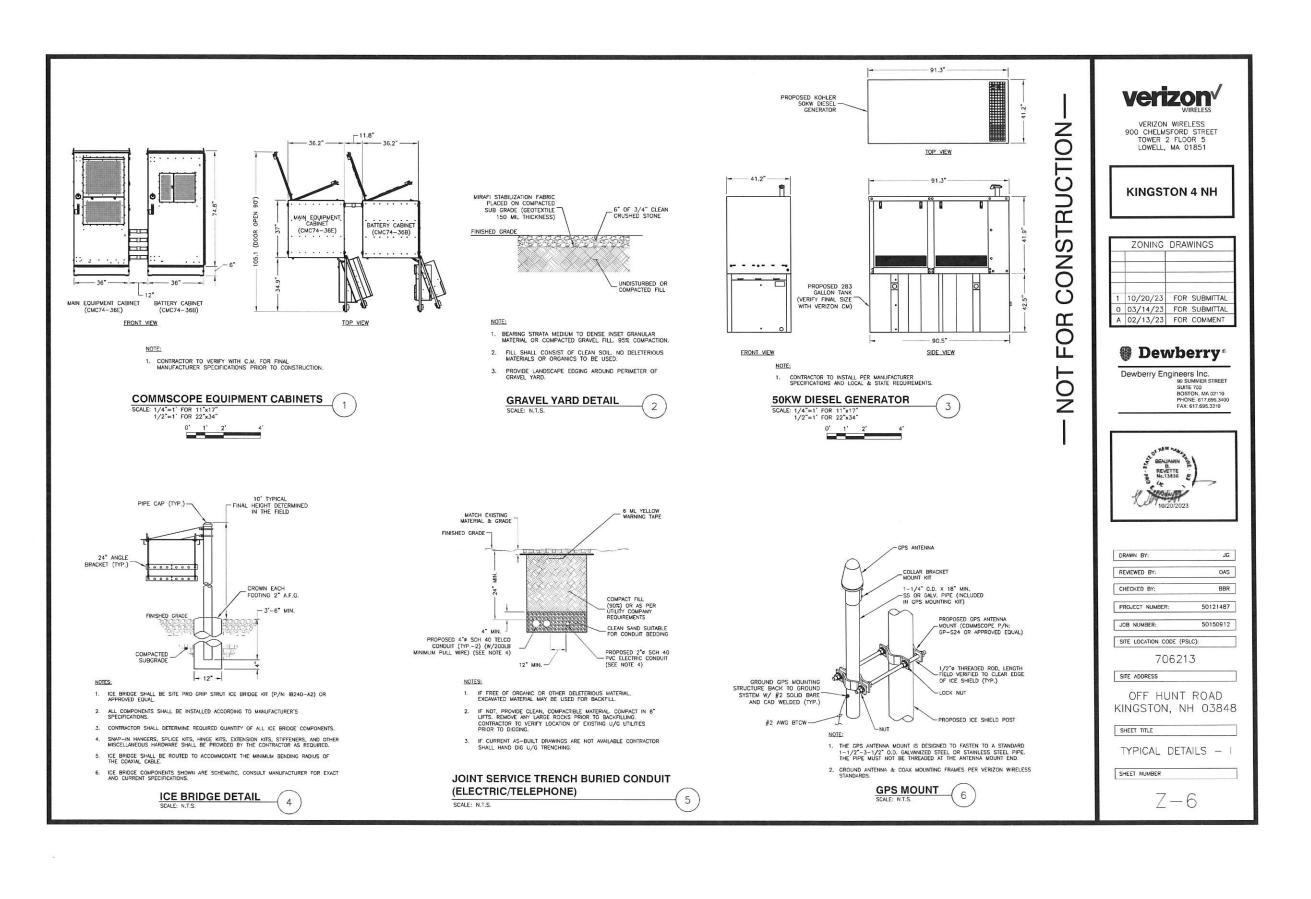

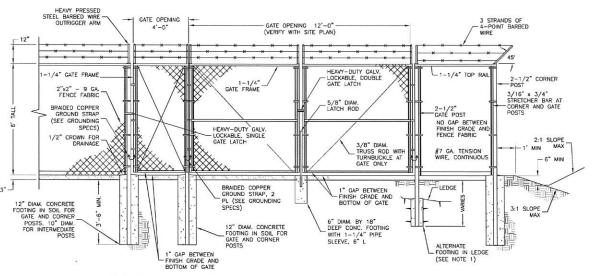

### FENCE NOTES:

- ALTERNATE FOOTINGS FOR ALL FENCE POSTS IN LEDGE: IF LEDGE IS ENCOUNTERED AT GRADE, OR AT A DEPTH SHALLOWER THAN 3"-6", CORE DRILL AN 8" DIA HOLE 18" INTO THE LEDGE. CENTER POST IN THE HOLE AND FILL WITH CONCRETE OR GROUT. IF LEDGE IS BELOW FINISH GRADE, COAT BACKFILLED SCETION OF POST WITH COAL TAR, AND BACKFILL WITH WELL-DRAINING GRAVEL.
- ATTACH EACH GATE WITH 1-1/2 PAIR OF NON-LIFT-OFF TYPE, MALLEABLE IRON OR FORGING, PIN-TYPE HINGES. ASSEMBLIES SHALL ALLOW FOR 180' OF GATE TRAVEL.



### **EROSION AND SEDIMENT CONTROL PLAN:**

DURING CONSTRUCTION AND THEREAFTER, EROSION CONTROL MEASURES ARE TO BE IMPLEMENTED AS NOTED:

- INSTALLATION OF SILITATION FENCES AND OTHER EROSION CONTROL MEASURES SHALL BE COMPLETED PRIOR TO THE START OF SITE WORK IN ANY GIVEN AREA PREFABRICATED SILITATION FENCES SHALL BE INSTALLED ACCORDING TO THE MANUFACTURER'S RECOMMENDATIONS.
- 3. EXISTING VEGETATION IS TO REMAIN UNDISTURBED WHEREVER POSSIBLE.
- THE AREA OF LAND EXPOSED AND THE TIME OF EXPOSURE SHALL BE MINIMIZED. ALL DISTURBED AREAS SHALL BE STABILIZED WITHIN 72 HOURS AFTER FINAL GRADING.
- 5. ALL DISTURBED AREAS SHALL HAVE A MINIMUM OF 6" OF LOAM, ACCEPTABLE SEED MIXES ARE AS FOLLOWS.

38%	CREEPING RED FESCUE	(MIN.	60 LBS/CRE
32%	PERENNIAL RYEGRASS	(MIN.	51 LBS/ACR
5%	REDTOP	(MIN.	8 LBS/ACRE
5%	ALSIKE CLOVER	(MIN.	8 LBS/ACRE
5%	BIRDSFOOT TREFOIL	(MIN.	8 LBS/ACRE
3%	LANCE-LEAF COREOPSIS	(MIN.	3 LBS/ACRE
3%	OXEYE DANSY	(MIN.	3 LBS/ACRE
3%	BUTTERFLY WEED	(MIN.	3 LBS/ACRE
3%	BLACKEYED SUSAN	(MIN.	3 LBS/ACRE

GENERAL SLOPE (NHDOT TYPE 44) MIX 3:1 OR GREATER SLOPES (MIN. 160 LBS/ACRE):


- 44% CREEPING RED FESCUE (MIN. 70 LBS/ACRE)
  38% PERENNIAL RYEGRASS (MIN. 50 LBS/ACRE)
  6% REDTOP (MIN. 10 LBS/ACRE)

- PLACING LOAM ON SITE:

  ALL SUBGRADE ELEVATIONS SHOULD BE UNIFORMLY GRADED TO RECEIVE LOAM AND SHALL BE
  INSPECTED AND APPROVED BY THE GENERAL CONTRACTOR PRIOR TO PLACEMENT OF LOAM.


  PLACE LOAM TO FORM A MINIMUM DEPTH OF 4" WHEN ROLLED, UNLESS OTHERWISE INDICATED.

  ALL DEPRESSIONS EXPOSED DURING THE ROLLING SHALL BE FILLED WITH ADDITIONAL LOAM.
- B. SEED BED PREPARATION:
  AFTER FINISH CRADING AND JUST BEFORE SEEDING, THE AREAS TO BE SEEDED SHALL BE LOOSENED
  TO PROVIDE A ROUGH, FIRM BUT FINELY PULVERIZED SEEDBED. THE INTENT IS TEXTIURE CAPABLE
  OF RETAININ WATER, SEED SHALL BE APPLIED TO THE CONDITIONED SEEDBED NOT MORE THAN 4B HOURS
  AFTER THE SEEDBED HAS BEEN PREPARED.

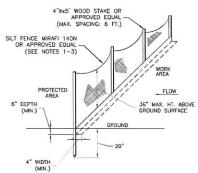


- THE FABRIC SHALL BE EMBEDDED A MINIMUM OF 6 INCHES IN DEPTH. AND 4 INCHES IN WIDTH IN A TRENCH EXCAVATED INTO THE GROUND, I STIE CONTIONS INCLUDE FROZEN GROUND, LEDGE, OR THE PRESENCE OF HEAVY ROOTS, THE BASE OF THE FABRIC SHALL BE LABEDDED WITH A MINIMUM THECKNESS OF 8 INCHES OF 3/4—INCH STONE.
- THE TRENCH SHALL BE EXCAVATED APPROXIMATELY 4 INCHES WIDE AND 6 INCHES DEEP ALONG THE LINE OF POSTS AND UPGRADIENT FROM THE BARRIER.
- 3. THE SOIL SHALL BE COMPACTED OVER THE EMBEDDED FABRIC.
- ADJOINING SECTIONS OF THE FENCE SHALL BE OVERLAPPED BY A MINIMUM OF 24 INCHES, FOLDED AND STAPLED TO A SUPPORT POST

SILT FENCE BARRIER

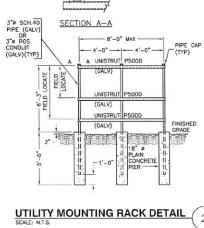

UNISTRUT PIPE/CONDUIT CLAMP P1119 OR P2558-35 (GALV.) (TYPICAL) FOLLOW MANUF, RECOMMEDIATIONS FOR BOLT TORQUE

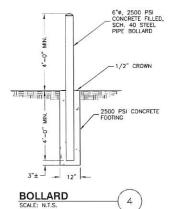

# verizon/

VERIZON WIRELESS 900 CHELMSFORD STREET TOWER 2 FLOOR 5 LOWELL, MA 01851

### **KINGSTON 4 NH**

CONSTRUCTION

 $\alpha$ 

NOT

	ZONING	DRAWINGS
1	10/20/23	FOR SUBMITTAL
0	03/14/23	FOR SUBMITTAL
Α	02/13/23	FOR COMMENT

## Dewberry\*

Dewberry Engineers Inc. 98 SUMMER STREET SUITE 700 BOSTON, MA 02110 PHONE 617.695.3400 FAX: 617.695.3310



DRAWN BY:	JG
REVIEWED BY:	OAS
CHECKED BY:	BBR
PROJECT NUMBER:	50121487
JOB NUMBER:	50150912
SITE LOCATION CODE	(PSLC):

SITE ADDRESS

OFF HUNT ROAD KINGSTON, NH 03848

SHEET TITLE TYPICAL DETAILS - II

SHEET NUMBER

Z-7